
# INSTALL CONDENSATE POLISHING SYSTEM

THE UNIVERSITY OF SOUTH CAROLINA COLUMBIA, SOUTH CAROLINA

STATE PROJECT # H27-Z215 / USC PROJECT # CP00426209

FACILITIES PLANNING AND CONSTRUCTION

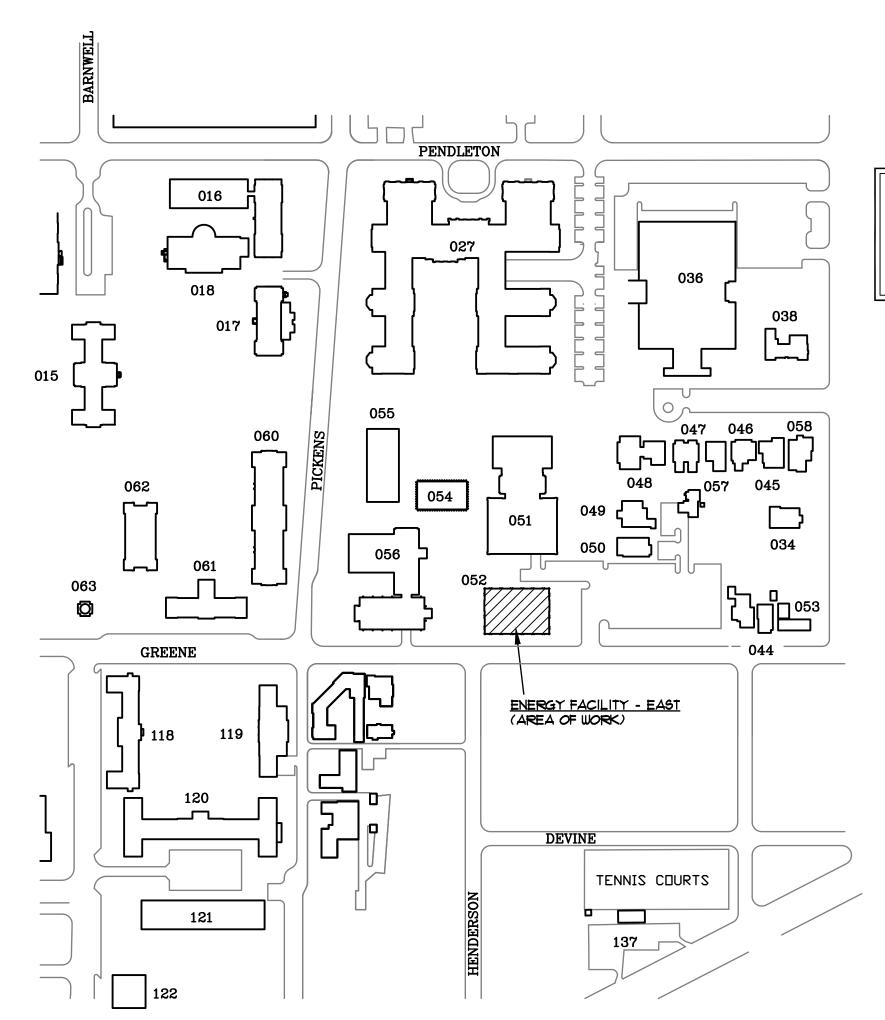


IT IS RECOMMENDED THAT THE CONTRACTOR VISIT OF A BID WILL BE CONSIDERED AS EVIDENCE THAT THE CONTRACTOR HAS VISITED THE SITE OF WORK


## MECHANICAL ENGINEER

MECHANICAL DESIGN, INC. 4403 BROAD RIVER ROAD COLUMBIA, S.C. 29210 (803) 731-9834

### ELECTRICAL ENGINEER

LAND ENGINEERING ASSOCIATES, LLC 262 SANDHURST ROAD, SUITE 101 COLUMBIA, S.C. 29210 (803) 528-1437

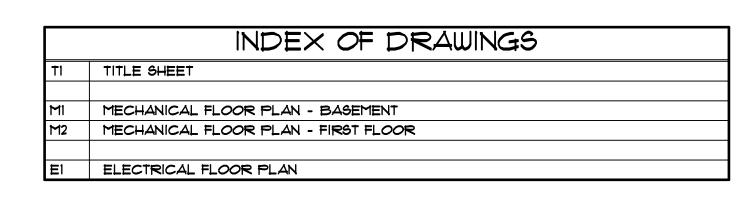


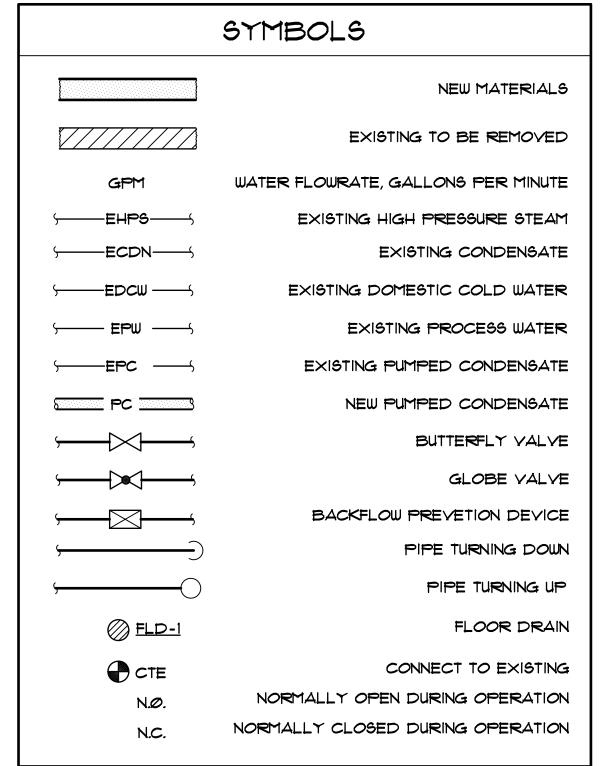

#### CODE REVIEW INFORMATION

PROJECT DESIGNED IS ACCORDANCE WITH: International Building Code - 2012 Edition. International Plumbing Code - 2012 Edition. International Mechanical Code - 2012 Edition. National Electric Code - 2011 Edition. Seismic Design Category D




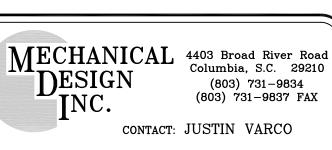


сомм. No. 153210


**MECHANICAL** DESIGN, INC.

Columbia, SC

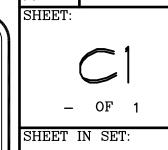

UNIVERSITY OF SOUTH CAROLINA NOT TO SCALE

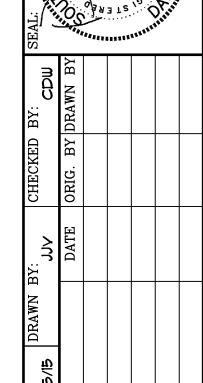

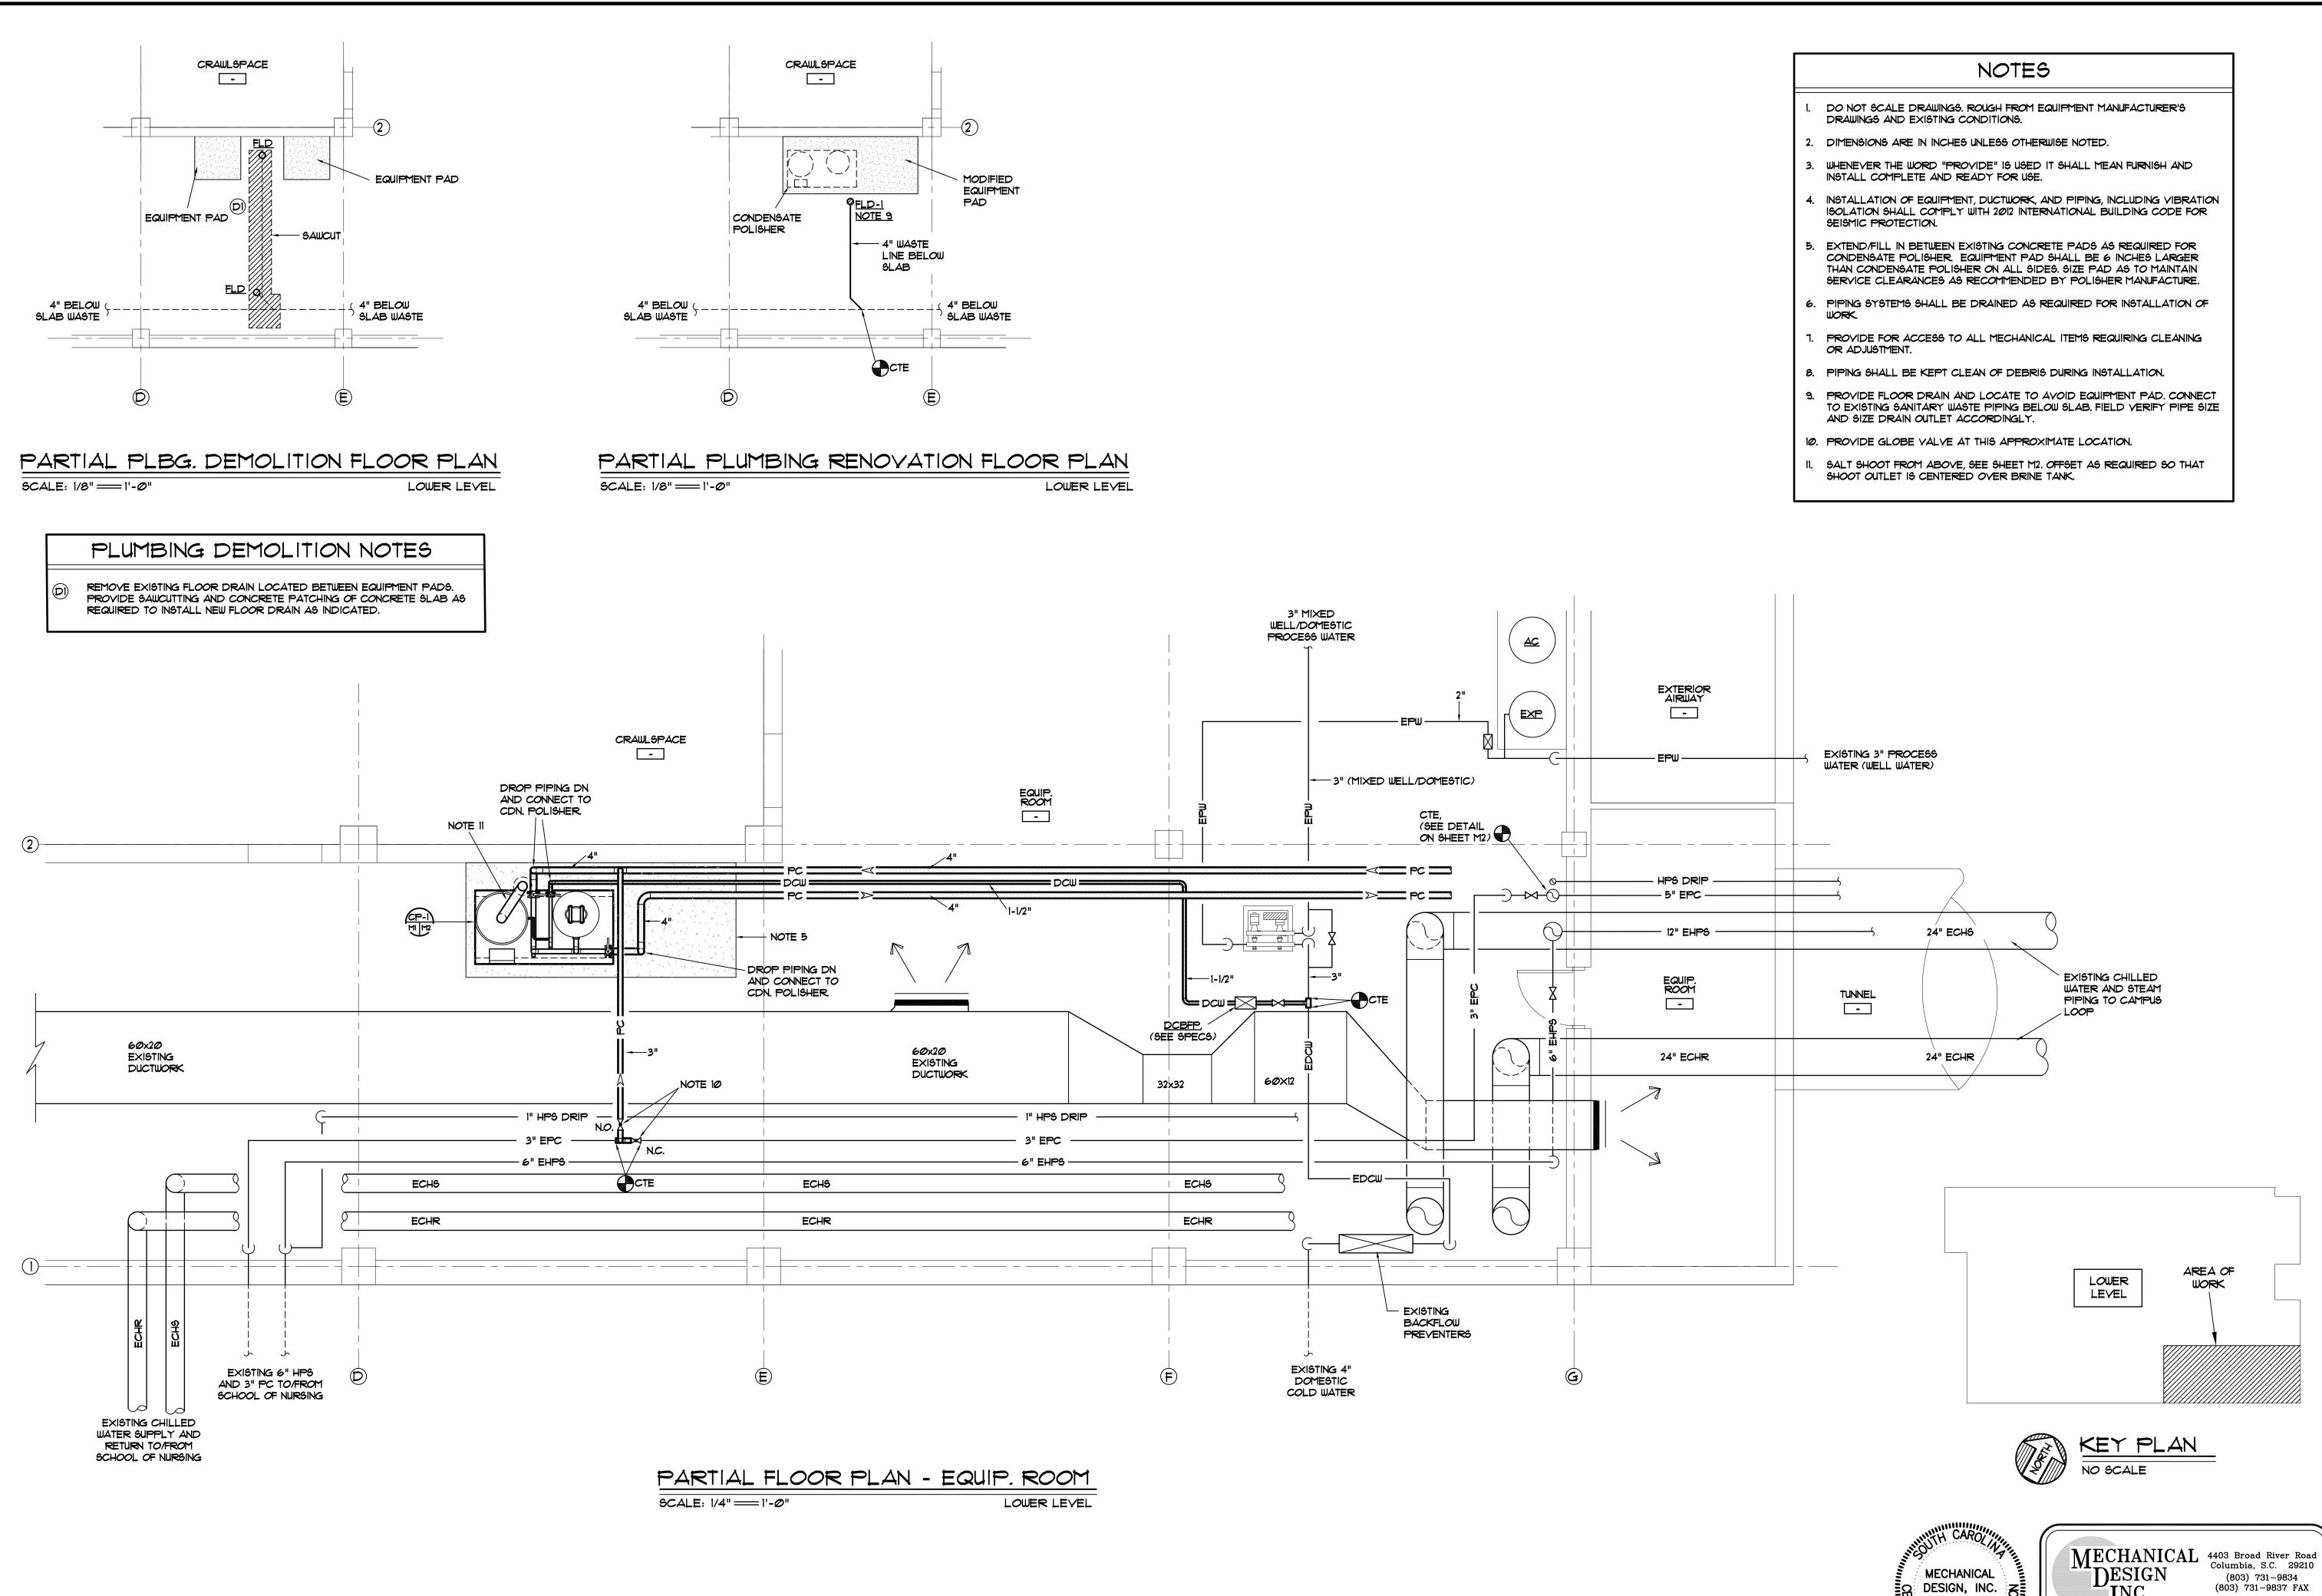

GEM] OF NA( OFFICE COLUMBIA, SI

– OF 2 SHEET IN SET:


OF

CONTACT: JUSTIN VARCO

сомм. No. 153210

DATE: 06/05/15

又COLUMBIA, SC

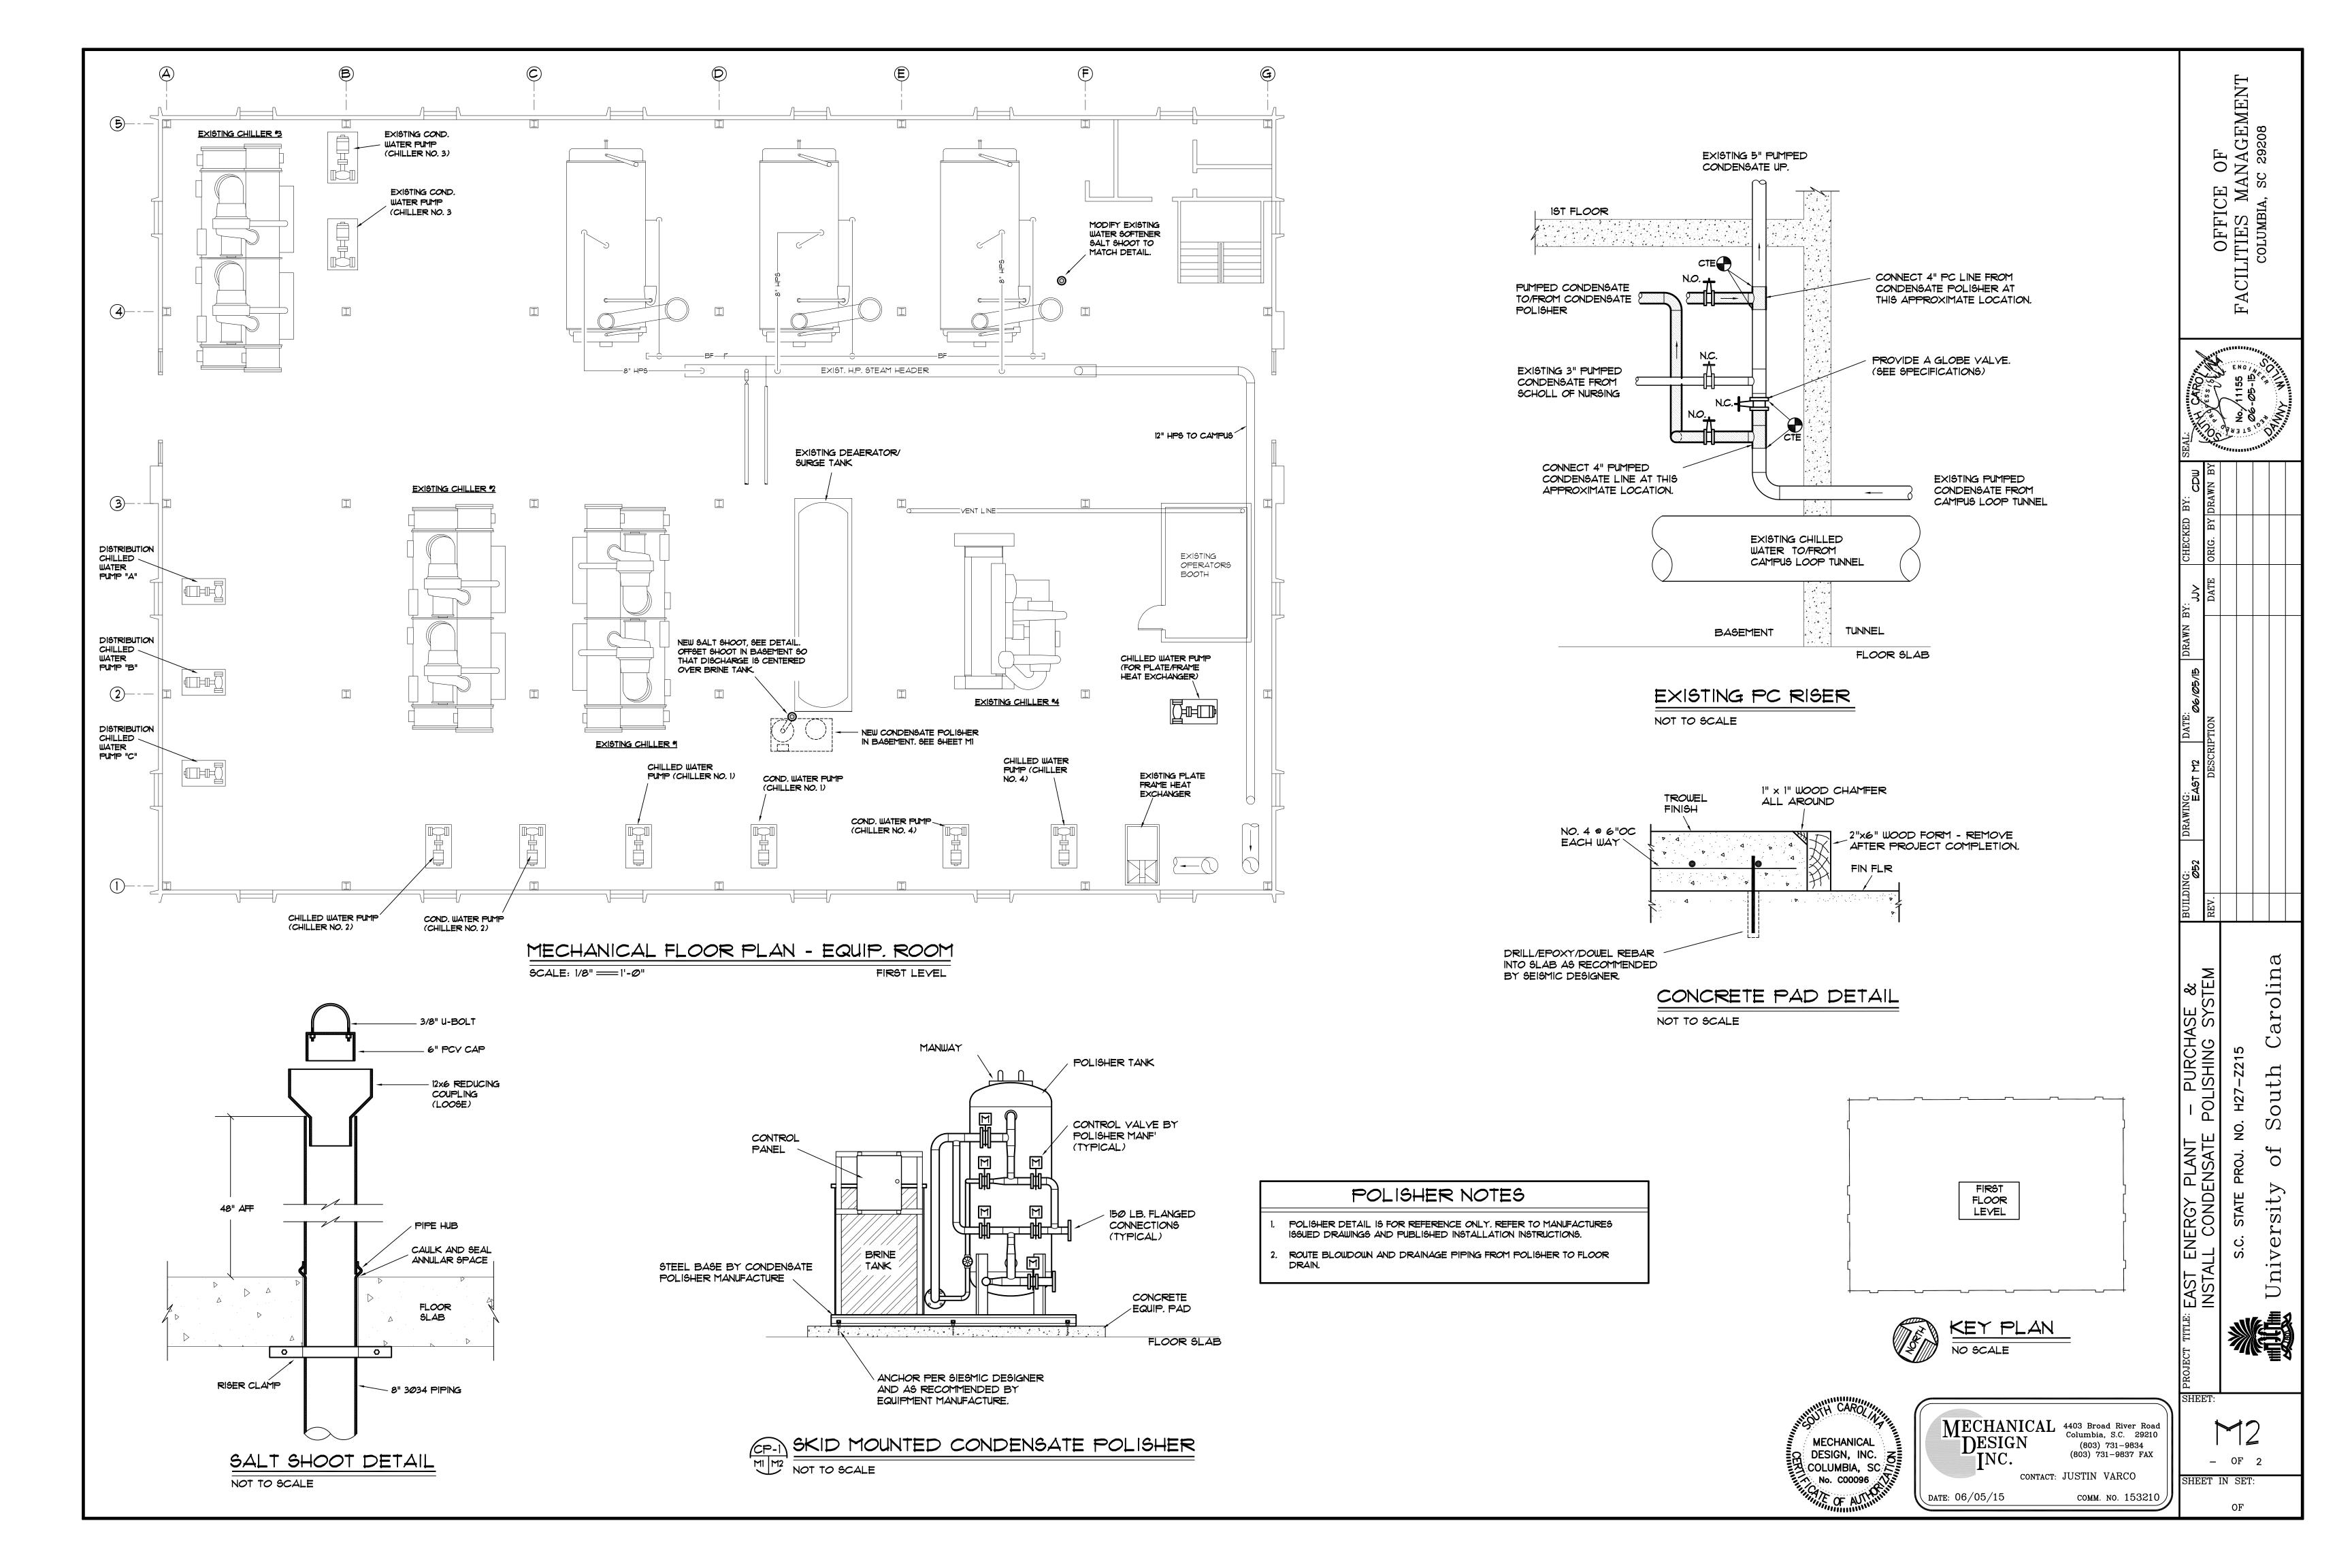

COLUMBIA, SC 293	
FACILITIES MANA(	
OFFICE OF	

C	FACILIT	T00	
CAROLITICA	LAND SNC: LLC	المجاب الم	OF ACIDITION OF AC

SEAL: WWW.W.W.W.	Sinn,	LAND LAND Z	ASSOC., LLC OF	COA-4406	A Single	
ED BY: JWL	BY DRAWN BY					
ED	ВҮ					

SEAL:	Sim	ERT	Ziii Ziii
JWL			
СНЕСКЕD ВҮ:	ORIG. BY		
SJSJ	DATE		

ВУ	Ы		
снескер ву	ORIG. BY DE		
JSJ	DATE		
DRAWN BY:			
DATE: DATE: 05JUN15	DESCRIPTION		
G:			

Carolina

South

USC-2015-03

1 of 1 SHEET IN SET:

\_ OF \_

#### ELECTRICAL NOTES 1. PANELBOARD "G-1": EXISTING PANELBOARD IS A GENERAL ELECTRIC LOAD CENTER. PROVIDE ONE 20-AMP RATED, SINGLE-POLE, GROUND FAULT INTERRUPT TYPE CIRCUIT BREAKER IN A BLANK SPACE OF PANELBOARD TO SERVE CONTROL POWER

TO NEW CONDENSATE POLISHER SYSTEM. UPDATE EXISTING PANELBOARD LOAD

SCHEDULE TO REFLECT ADDED LOAD.

ELECTRICAL LEGEND

EXISTING PANELBOARD - TO REMAIN IN PLACE.

ELECTRICAL CODE.

ELECTRICAL CODE.

DESCRIPTION

SINGLE-POLE TOGGLE SWITCH RATED 20 AMPS, 120 VOLTS WITH PILOT LIGHT (PROVIDE PASS & SEYMOUR #PS20AC1RPL OR EQUAL). PILOT

LIGHT SHALL BE "LIGHTED WHEN ON". PROVIDE A CAST METAL BACKBOX

CAST METAL JUNCTION BOX WITH GASKETED SCREW COVER - CEILING

FOR SWITCH WITH GASKETED SWITCH-TYPE METAL COVERPLATE.


MOUNTED. SUPPORT BOX IN ACCORDANCE WITH THE NATIONAL


MOUNTED. SUPPORT BOX IN ACCORDANCE WITH THE NATIONAL

CAST METAL JUNCTION BOX WITH GASKETED SCREW COVER - UNIT

SYMBOL

- 2. CONTROL POWER: PROVIDE TWO #12 AWG THHN COPPER CONDUCTORS WITH ONE #12 AWG GREEN INSULATED COPPER GROUND WIRE IN 3/4" RIGID METALLIC CONDUIT (RMC WITH THREADED FITTINGS) FROM PANELBOARD TO CONDENSATE POLISHER SYSTEM - VERIFY CONNECTION POINT ON SYSTEM WITH THE MECHANICAL CONTRACTOR. FINAL RACEWAY CONNECTION TO THE CONDENSATE POLISHER SYSTEM SHALL BE MADE WITH LIQUID-TIGHT FLEXIBLE METAL CONDUIT.
- 3. PROVIDE ALL WORK IN ACCORDANCE WITH THE 2011 EDITION OF THE NATIONAL ELECTRICAL CODE.

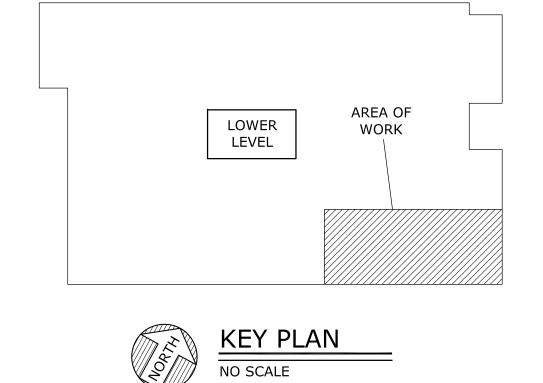

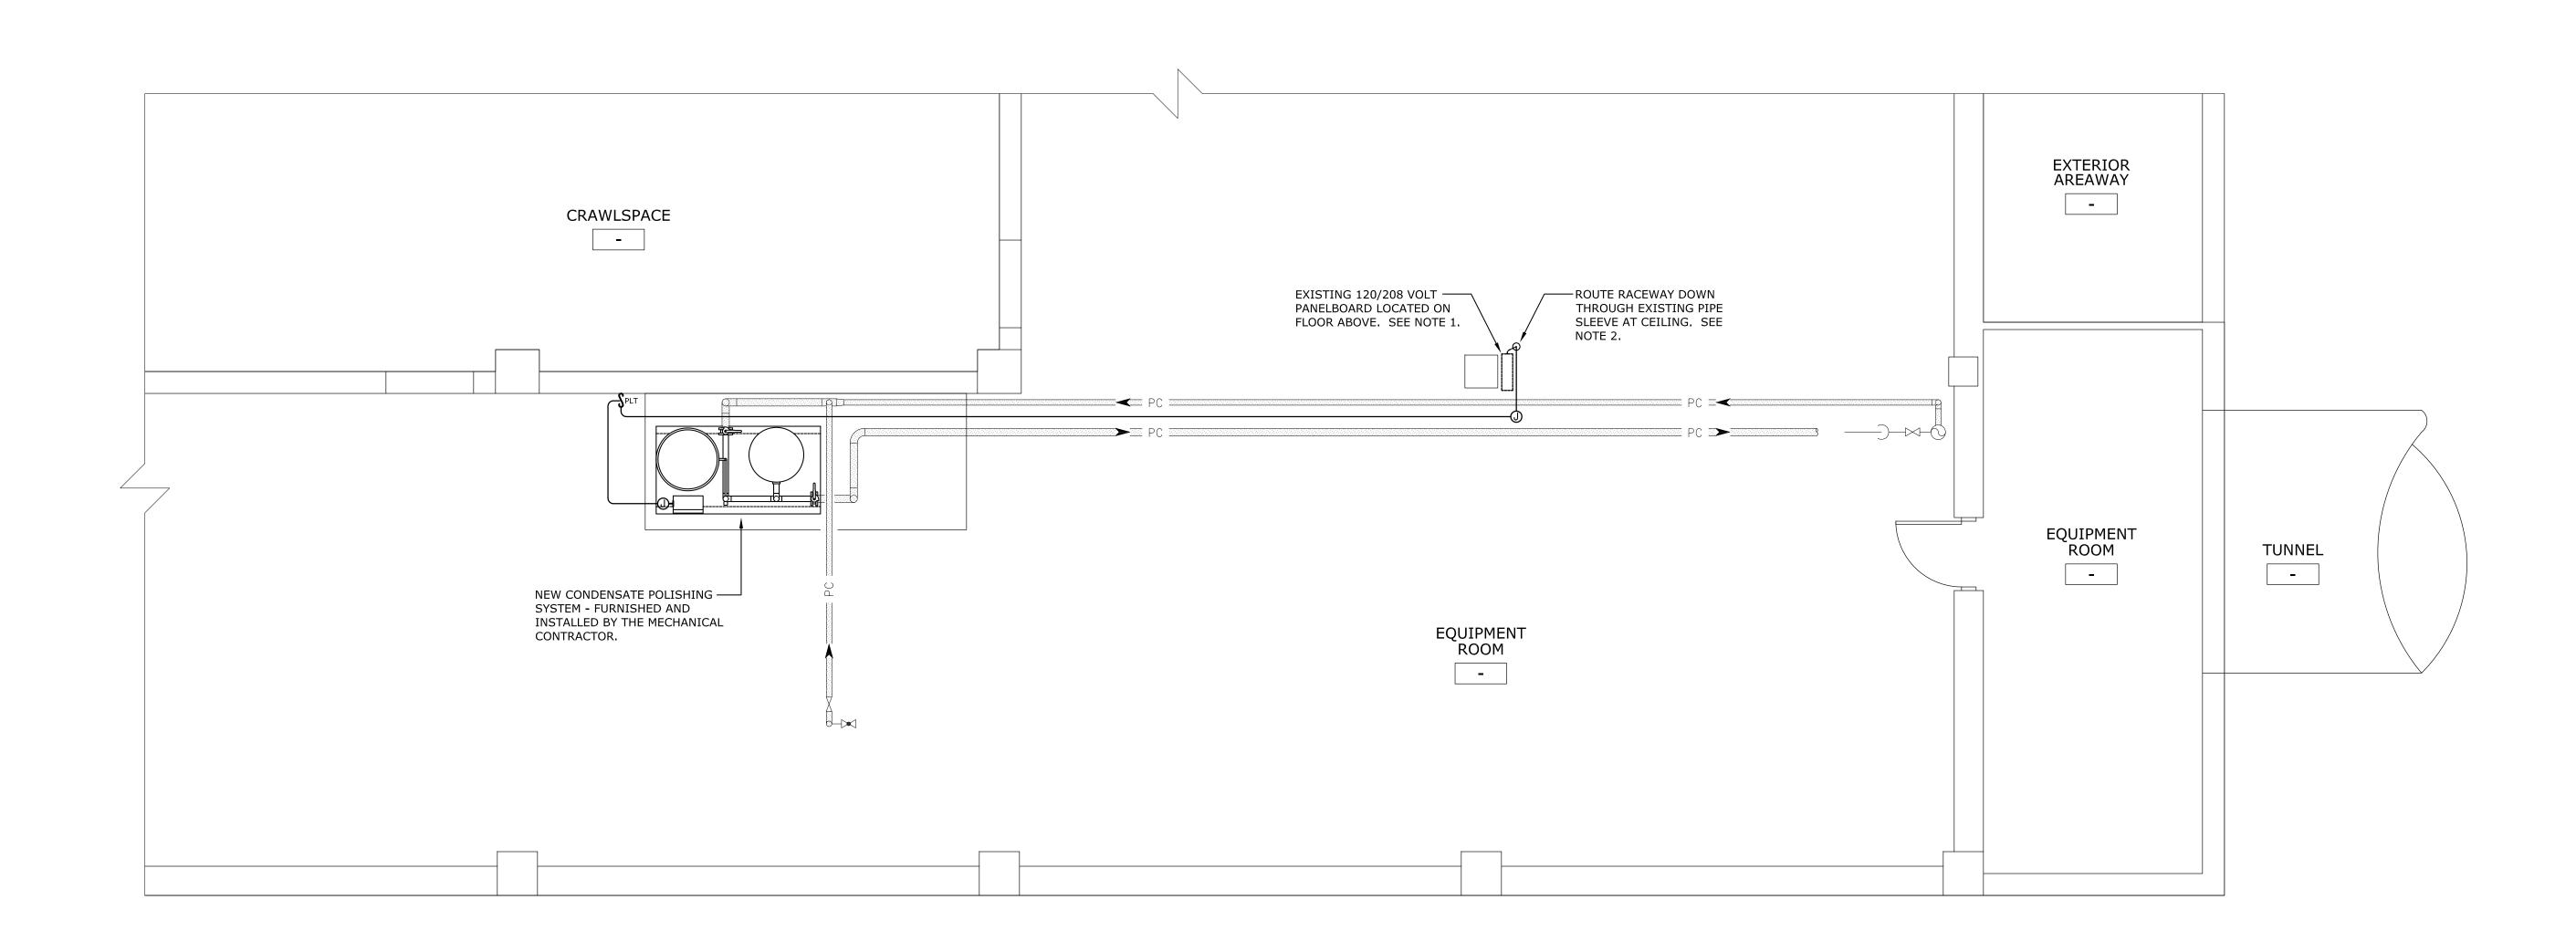

PARTIAL FLOOR PLAN - EQUIPMENT ROOM SCALE: 1/4" = 1'-0" LOWER LEVEL

